





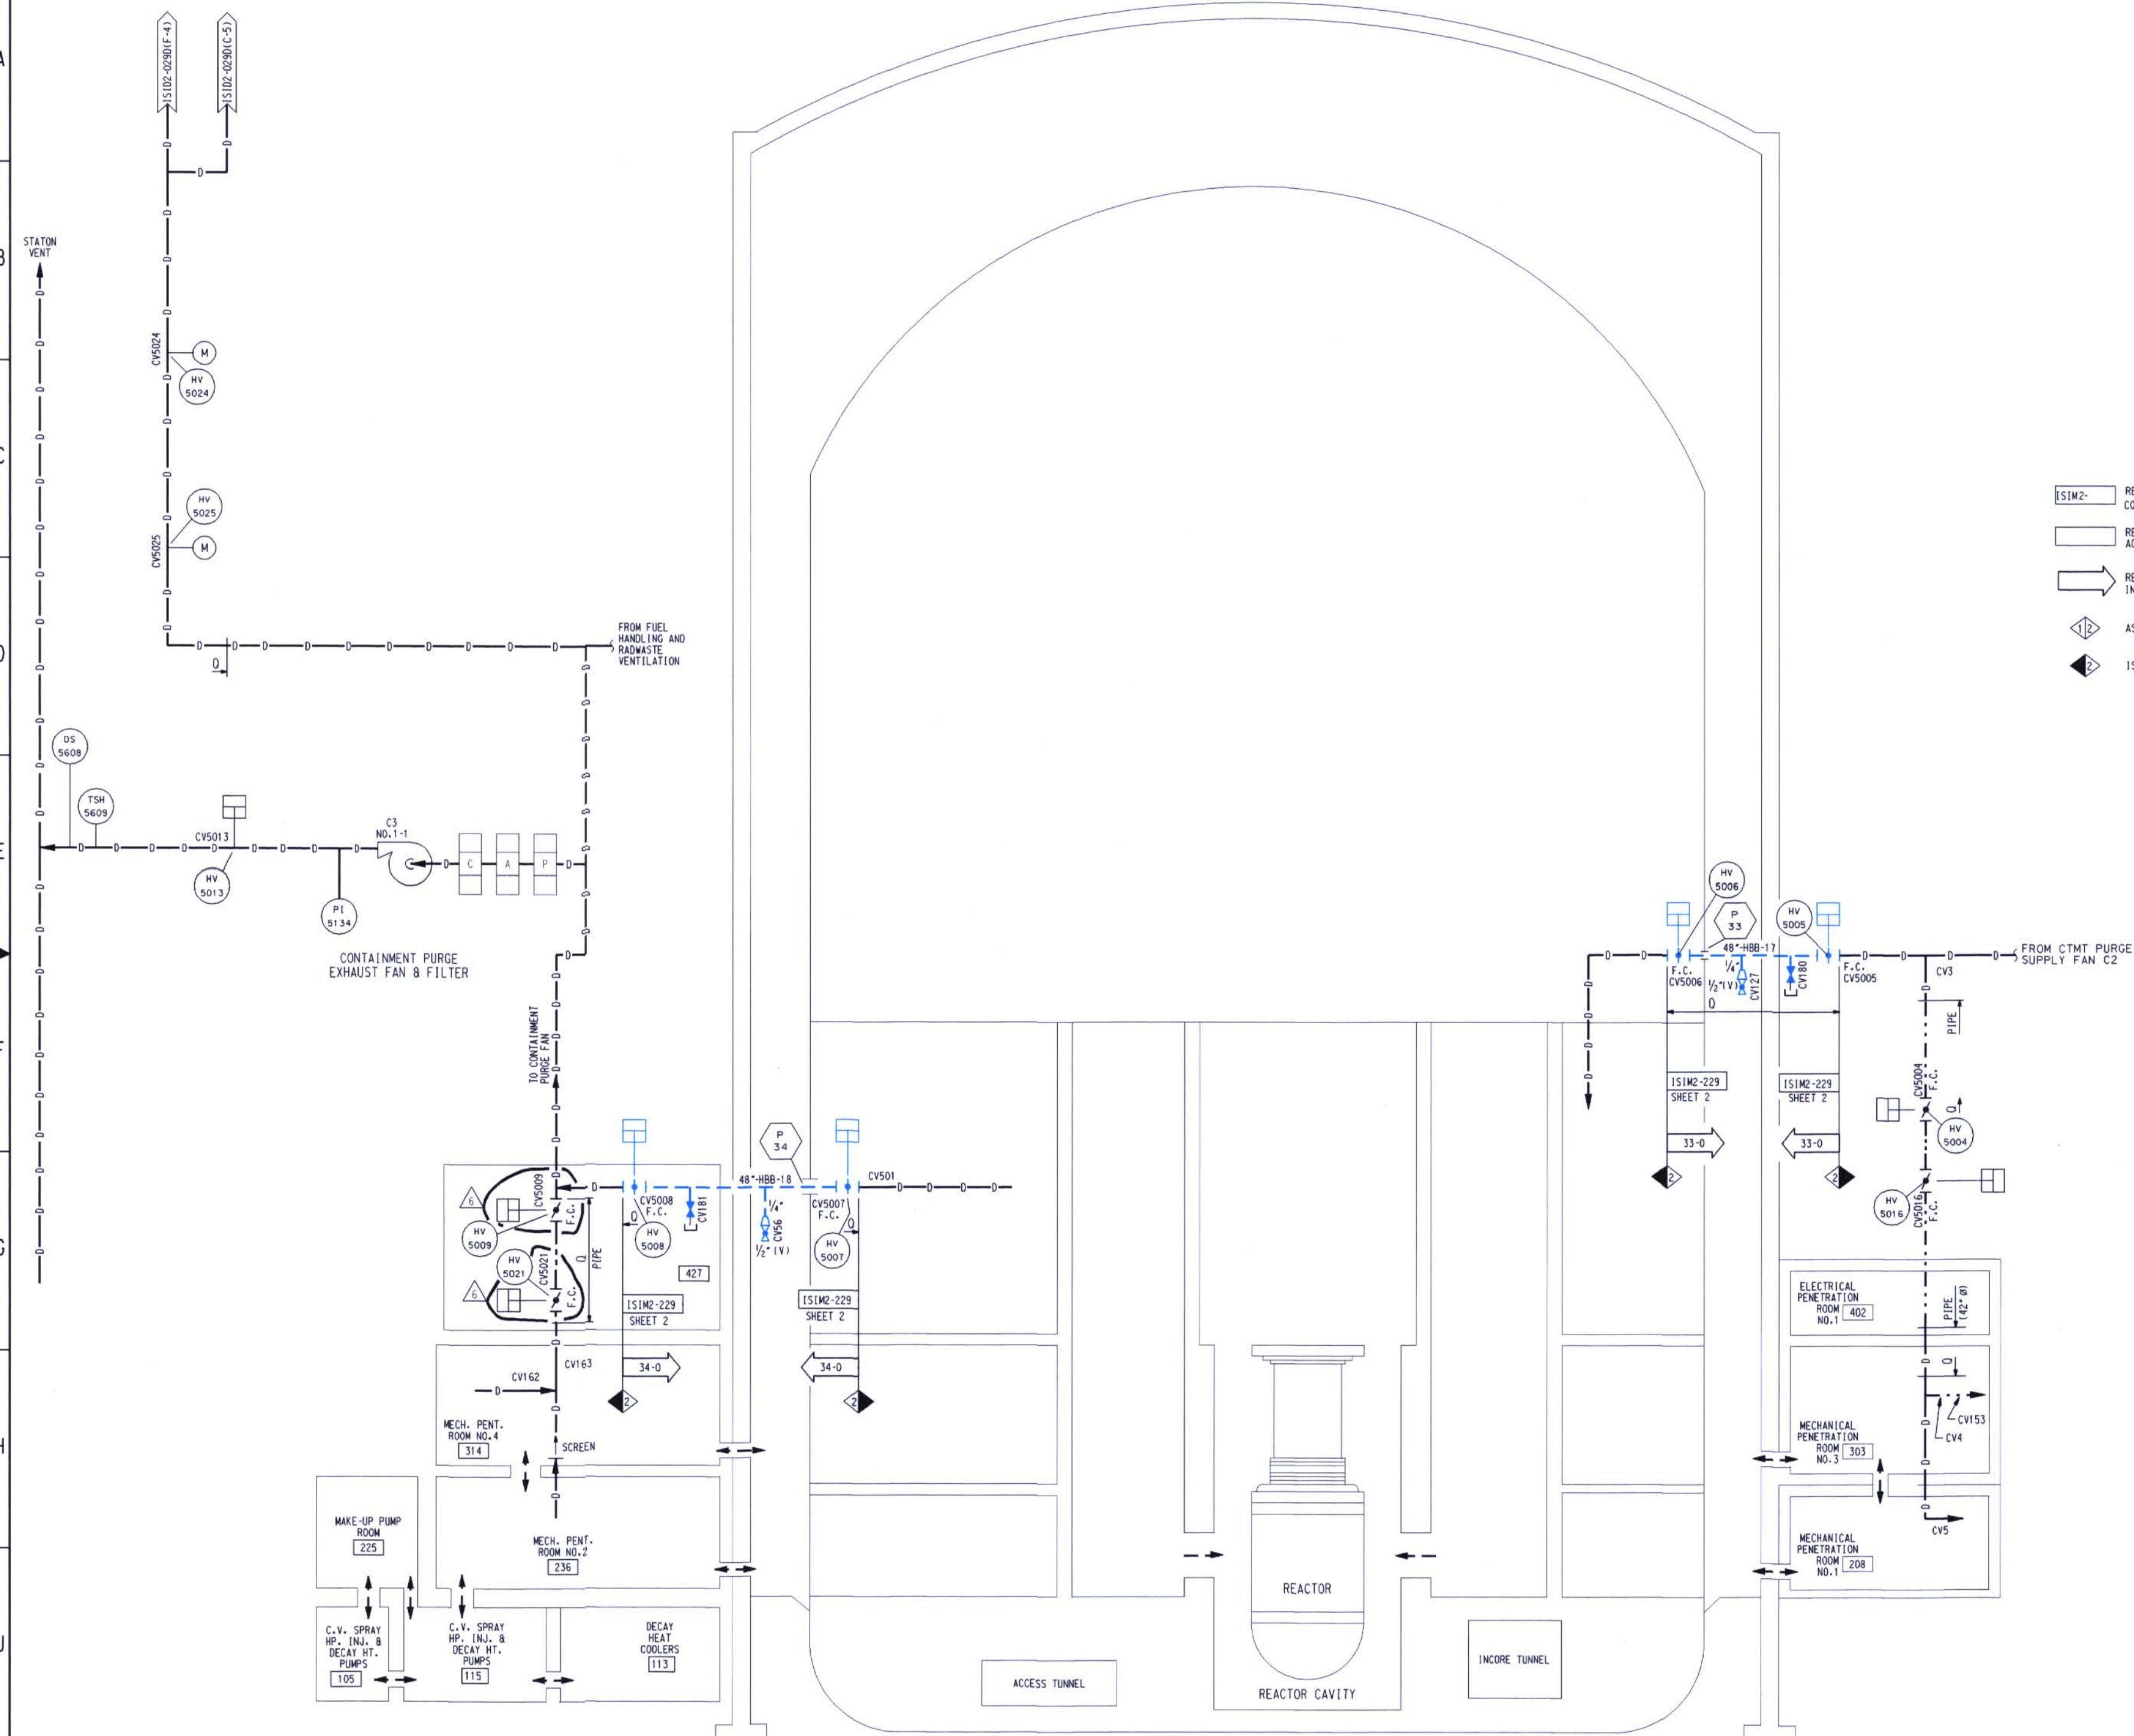

STATON

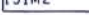

- | | |
|---|---|
|  | REFERENCE TO THE PIPING ISOMETRIC DRAWING FOR DETAILS ON THE PIPING CONFIGURATION, AND THE LOCATION AND IDENTIFICATION OF WELDS AND SUPPORTS. |
|  | RESERVED FOR SPECIAL ISI REQUIREMENTS. (MAY BE) ACCOMPANIED BY SPECIFIC NOTES. |
|  | REFERENCE TO THE ISI ITEM NUMBER DESIGNATION USED IN THE FIRST 10 YEAR INSERVICE INSPECTION INTERVAL. |
|  | ASME SECTION XI CLASS CHANGE |
|  | ISI PROGRAM BOUNDARY |

NOTES:

1. DELETED
2. FOR ISI BOUNDARY DIAGRAM INDEX SHEET AND GENERAL NOTES, SEE ISID2-001.
3. FOR PIPING SYMBOLS AND P & ID INDEX, SEE DRAWING M-001.

D-016

6	1	INC DCM IS1D2-0296-6 PER DOR 01-16-85	SW
5	1/2/85	INC DCM IS1D2-0296-5 PER DOR 00-17-86	"INITIALS ON FILE"
4	1/2/85	INC DCM IS1D2-0296-4 FOR DOR 94-0067	"INITIALS ON FILE"
3	02/16/85	INC DCM IS1D2-0296-3 FOR DOR 93-03-85	"INITIALS ON FILE"
2	1/2/85	INC DCM IS1D2-0296-2 FOR RFA 93-0171	"INITIALS ON FILE"
1	9/17/83	INC DCM IS1D2-0296-1 FOR DOR 81-0001	"INITIALS ON FILE"
0	9/17/83	ISSUED FOR SECOND 10 YEAR 151 PROGRAM	"INITIALS ON FILE"
NO.	DATE	REVISIONS	BY CHG. ENGR. EMPL. ENGR. NO.
SCALE N.T.S.		DESIGNED	DRAWN <input type="checkbox"/> DATE
DAVIS-BESSE NUCLEAR POWER STATION			
UNIT NO. 1			
THE TOLSON DESIGN COMPANY			
INSERVICE INSPECTION DIAGRAM			
CONTAINMENT AND PENETRATION ROOMS			
SHT. 4			
DRAWING NO.			REV.
IS1D2-0296			6